


BRIDGE PLAN VIEW

SCALE: 1" = 50'

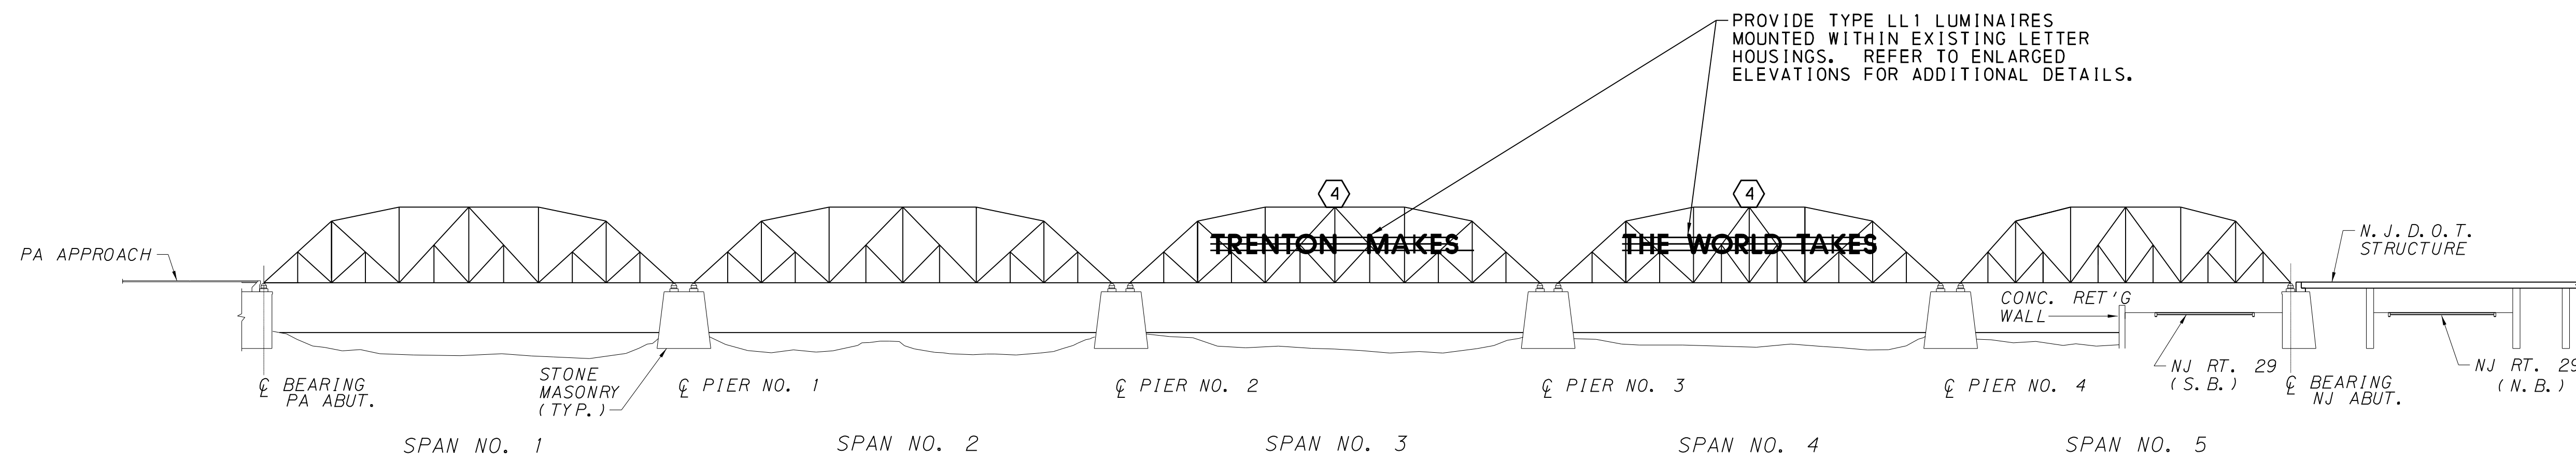

TRUSS ELEVATION VIEW - LOOKING NORTH

SCALE: 1" = 50'

NOTE:

- FOR SIGN LETTER DETAILS, SEE SIGN DETAIL SHEETS.
- FOR ELECTRICAL REQUIREMENTS & DETAILS, SEE ELECTRICAL DRAWINGS.
- FOR GENERAL NOTES, SEE SHEET 2.
- TRAFFIC PATTERNS SHOWN ARE FOR THE EXISTING/PROPOSED CONDITION. SEE TRAFFIC CONTROL DRAWINGS FOR TRAFFIC PATTERNS DURING CONSTRUCTION.

KEYED ELECTRICAL NOTES:

- EXISTING TIMECLOCK TO BE REPLACED WITH CURRENT MANUFACTURER'S REPLACEMENT MODEL.
- EXISTING PANELBOARD TO BE REPLACED WITH 100A, 120/204V, 1P3W SPLIT-BUS IN NEMA 4X ENCLOSURE. REUSE EXISTING PANEL FEEDER. REPLACE CONDUCTORS FROM TIME CLOCK TO NEW SPLIT-BUS PANEL LCP. PROVIDE 4 #6, #10 GRD. - 1" C. SEE SHEET 7 FOR PANEL SCHEDULE.
- PROVIDE 20A, 120V, GFI, WP DUPLEX RECEPTACLE BELOW NEW PANELBOARD.
- REMOVE ALL EXISTING TRANSFORMERS, NEON TUBES, BRACKETS, WIRING, ETC. FROM LETTER HOUSINGS. REMOVE ALL CONDUCTORS FROM LETTER HOUSINGS TO PANEL, RETAIN CONDUIT FOR REUSE.


DELAWARE RIVER JOINT TOLL BRIDGE COMMISSION
MORRISVILLE BOROUGH, BUCKS COUNTY, PENNSYLVANIA
AND
CITY OF TRENTON, MERCER COUNTY, NEW JERSEY

**LOWER TRENTON TOLL-SUPPORTED
BRIDGE REPLACEMENT OF SIGN
LIGHTING ELEMENTS**

LIGHTING PLAN AND ELEVATION

SCALE: AS SHOWN	CONTRACT NO.	DWG. NO.	SHEET NO.
DATE: MAR 28, 2017	TS-687A	1 OF 6	4 OF 12

PREPARED BY:
DEWBERRY ENGINEERS INC.

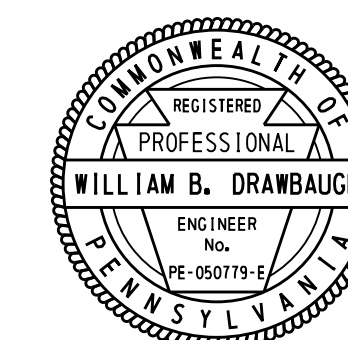

Mark	Description	By	Chk'd.	Recm'd.	Date
REVISIONS					